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REVISIONS

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11/05/2025

**JPS ARLINGTON SURGERY
OR HVAC REPLACEMENT PROJECT
4400 NEW YORK AVE.
ARLINGTON, TX 76018**

PROJECT #: 05194.09

SHEET TITLE:
ELECTRICAL
COVER

SHEET #:

E-001

ELECTRICAL ABBREVIATIONS, SYMBOLS, AND NOTES		
ABBREVIATIONS	SWITCHES & MISC.	GENERAL NOTES
AC	ALTERNATING CURRENT	
ADO	AUTOMATIC DOOR OPENER	
AF	AMPERE FRAME	
AFC	ABOVE FINISHED COUNTER	
AFF	ABOVE FINISHED FLOOR	
AT	AMPERE TRIP	
ATS	AUTOMATIC TRANSFER SWITCH	
C	CONDUIT	
CB,CB,CKT BKR	CIRCUIT BREAKER	
CKT	CIRCUIT	
CLG	CEILING	
D	DEMOLITION	
DC	DIRECT CURRENT	
DP	DISTRIBUTION PANEL	
EG	EQUIPMENT GROUND	
ELEC	ELECTRIC	
E, EM	EMERGENCY	
EP	EXPLOSION PROOF	
EWC	ELECTRIC WATER COOLER	
EX	EXISTING	
F	FUSE	
FA	FIRE ALARM	
FAA	FIRE ALARM ANNUNCIATOR	
FACU	FIRE ALARM CONTROL UNIT	
FCU	FAN COL UNIT	
FLA	FULL LOAD AMPS	
FTU	FAN TERMINAL UNIT	
G, GND	GROUND	
GEN	GENERATOR	
GF/GFCI	GROUND FAULT CIRCUIT INTERRUPTER	
H	HIGH POWER	
HV, H	HIGH VOLTAGE PANEL (277/480V)	
IC	ISOLATED GROUND	
JB, JBOX, J-BOX	JUNCTION BOX	
LTG	LIGHTING	
LV	LOW VOLTAGE PANEL (120/208V)	
MCA	MINIMUM CIRCUIT AMPS	
MCB	MAIN CIRCUIT BREAKER	
MCC	MOTOR CONTROL CENTER	
MDP	MAIN DISTRIBUTION PANEL	
MH	MANHOLE	
MLO	MAIN LUGS ONLY	
MTD	MONTE	
MTG HGT	MOUNTING HEIGHT	
NAC	NOTIFICATION AMPLIFICATION CIRCUIT	
NF	NON-FUSED	
NFSS	NON-FUSED SAFETY SWITCH	
P	POLE	
PH	PHASE	
PB	PULL BOX	
PNL	PANEL	
POD	POWER OPERATED DAMPER	
PWR	POWER	
R	RELOCATED DEVICE	
RECEPT,RCPT	RECEPACLE	
TEL	TELEPHONE	
TR	TAMPER RESISTANT	
TV	TELEVISION	
UH	UNIT HEATER	
UON	UNLESS OTHERWISE NOTED	
V	VOLTAGE	
VFD	VARIABLE FREQUENCY DRIVE	
VP	VAPOR PROOF	
W	WIRE	
W/	WITH	
WP	WEATHER PROOF	
XFMR, XFR, T	TRANSFORMER	
UNIVERSAL		
WALL BRACKET	FIRE ALARM ELEVATION 7'-4"	
	LIGHTING ELEVATION REFER TO FIXTURE SCHEDULE	
	POWER ELEVATION REFER TO EQUIPMENT INSTALL MANUAL	
WIRING		
HOMERUN		
—	NEUTRAL WIRE (SHORT STROKE)	
—	PHASE OR SWITHED WIRE (LONG STROKE)	
—●	GROUND WIRE (FILLED CIRCLE)	
—○	ISOLATED GROUND WIRE (OPEN CIRCLE)	
↓	GROUND	
△	GROUNDING TRIAD	
—	CONDUIT CONCEALED IN WALL OR ABOVE CEILING	
—	CONDUIT CONCEALED IN SLAB, UNDER FLOOR, OR BELOW GRADE	
TRANSFORMERS & PANELS		
T	TRANSFORMER	
—	PANEL BOARD (480/277 VOLT)	
▨	SWITCHBOARD / DISTRIBUTION PANEL (480/277 VOLT)	
—	PANEL BOARD (208/120 VOLT)	
▨	SWITCHBOARD / DISTRIBUTION PANEL (208/120 VOLT)	
NOTE: NOT ALL SYMBOLS MAY BE USED.		
ONE LINE/RISER DIAGRAM		
AMPS/POLES	SWITCH	
AMPS/POLES	FUSE	
AMPS/POLES	MOLDED CASE CIRCUIT BREAKER	
AMPS/POLES	DRAW OUT CIRCUIT BREAKER	
AMPS/POLES	AUTOMATIC TRANSFER SWITCH	
—	GROUND ROD	
M	METER	
—	GROUND FAULT RELAY	
—	FRAME RATING	
—	TRIP RATING	
—	LSI	
—	LSIG	
—	LSIA	
—	ELECTRONIC TRIP FUNCTIONS	
—	TRANSFORMER	
—	NEUTRAL AND GROUND BUS.	
—	ARC INDICATES N-G BOND.	
CODES 2020 NEC 2021 IECC		

ISSUES

REVISIONS




11/05/2025

**JPS ARLINGTON SURGERY
OR HVAC REPLACEMENT PROJECT
4400 NEW YORK AVE.
ARLINGTON, TX 76018**

PROJECT #: 05194.09

SHEET TITLE:
PARTIAL
ELECTRICAL
DEMOLITION PLAN
SHEET #:

E-011

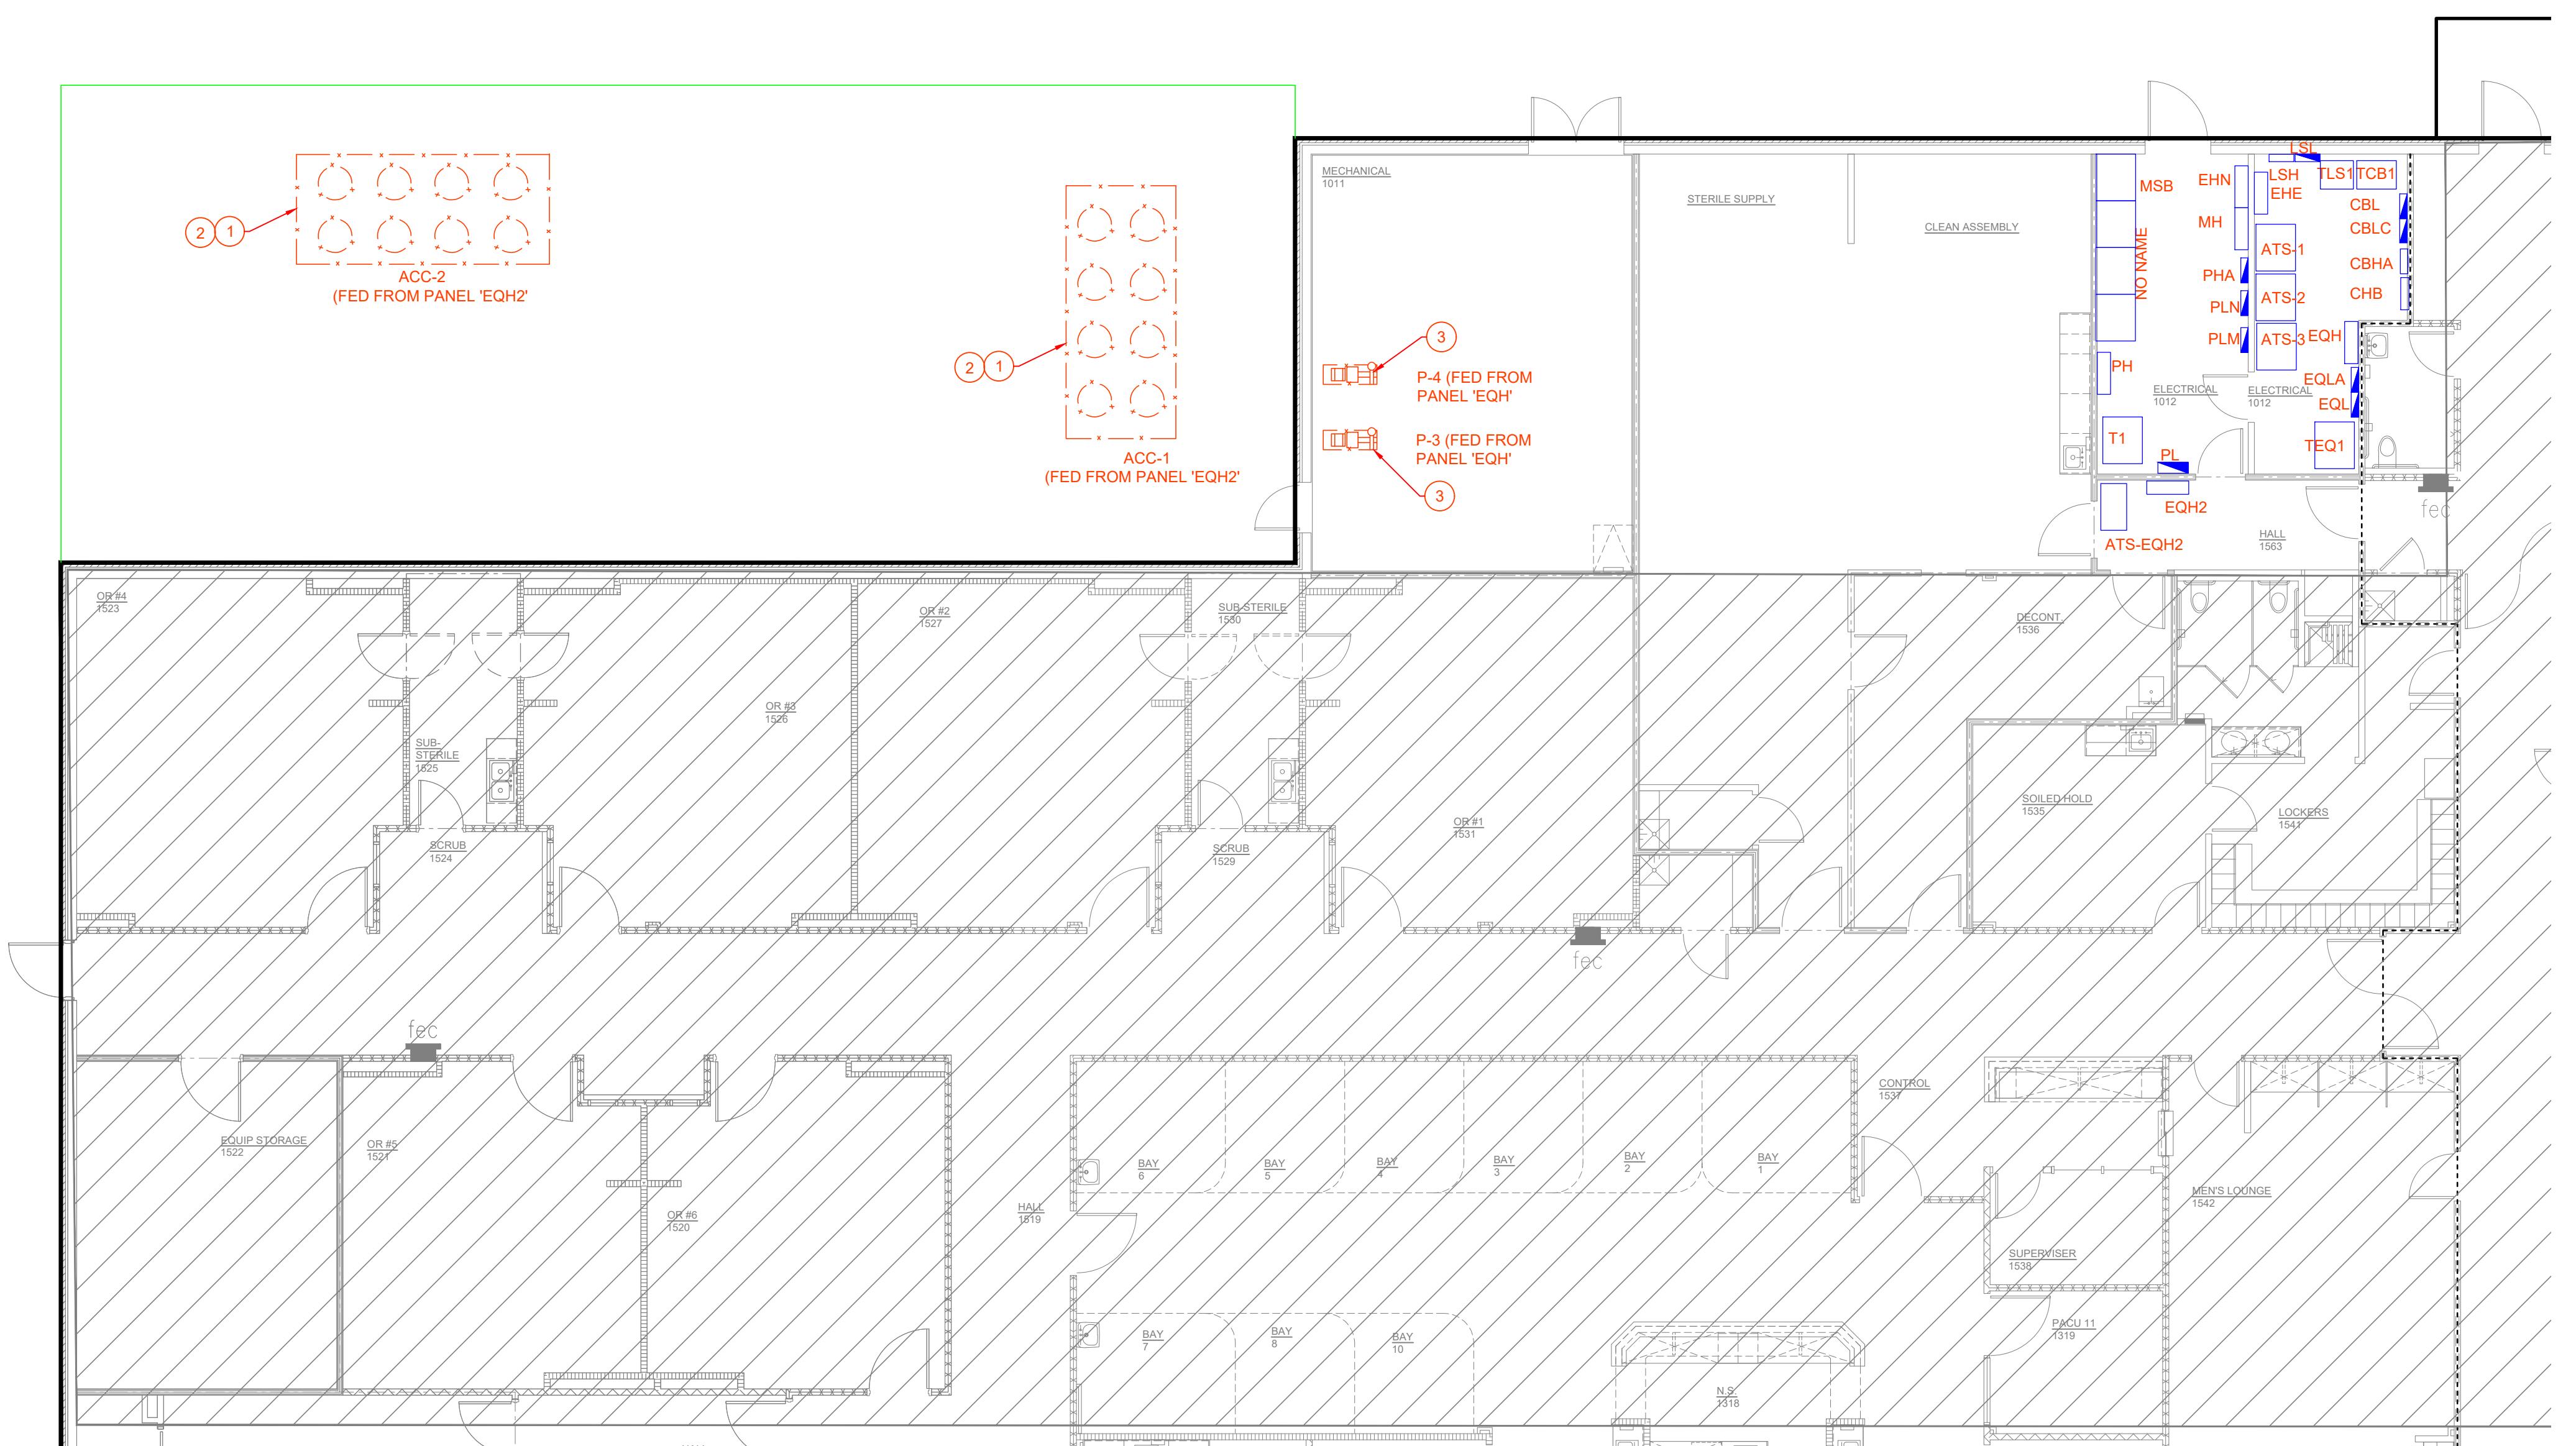


01

PARTIAL ELECTRICAL DEMOLITION PLAN

SCALE: 1/8" = 1'-0"

GENERAL NOTES:
1. REFER TO SHEET E-001 FOR LEGEND, ABBREVIATIONS, AND GENERAL PROJECT NOTES.
2. VERIFY EXACT LOCATIONS FOR HVAC EQUIPMENT WITH MECHANICAL DRAWINGS.
3. ALL ELECTRICAL PANELS AND TRANSFORMERS ARE EXISTING TO REMAIN.


ELECTRICAL DEMOLITION KEYED NOTES:
① DISCONNECT ELECTRICAL CONNECTION TO THE EXISTING CHILLER. REMOVE DISCONNECT, REMOVE CONDUIT AND WIRING BACK TO POWER SOURCE. REFER TO SHEET E-301 FOR CIRCUITING.
② EXISTING LOW VOLTAGE CIRCUITS (RECEPTACLE, HEAT TRACE, ... ETC) TO REMAIN. SUPPORT HUMIDIFIER AND RECEPTACLE AND REINSTALL.
③ DISCONNECT ELECTRICAL CONNECTION TO THE EXISTING ELECTRICAL PUMP. REMOVE CONDUIT AND WIRING BACK TO POWER SOURCE.
④ DISCONNECT ELECTRICAL CONNECTION TO THE EXISTING AIR HANDLING UNIT (AHU) RETURN AIR FAN. REMOVE DISCONNECT SWITCH, CONDUIT, AND WIRING BACK TO POWER SOURCE. REMOVE EXISTING 3P/30A RFA CIRCUIT BREAKER IN PANEL 'EQH'.
⑤ DISCONNECT ELECTRICAL CONNECTION TO THE EXISTING AIR HANDLING UNIT (AHU) SUPPLY AIR FAN. REMOVE DISCONNECT SWITCH, CONDUIT, AND WIRING BACK TO POWER SOURCE. REMOVE EXISTING 3P/30A RFA CIRCUIT BREAKER IN PANEL 'EQH'.
⑥ DISCONNECT ELECTRICAL CONNECTION TO THE EXISTING HUMIDIFIER. REMOVE DISCONNECT SWITCH, CONDUIT, AND WIRING BACK TO POWER SOURCE. REMOVE EXISTING CIRCUIT BREAKER IN PANEL 'MH'.

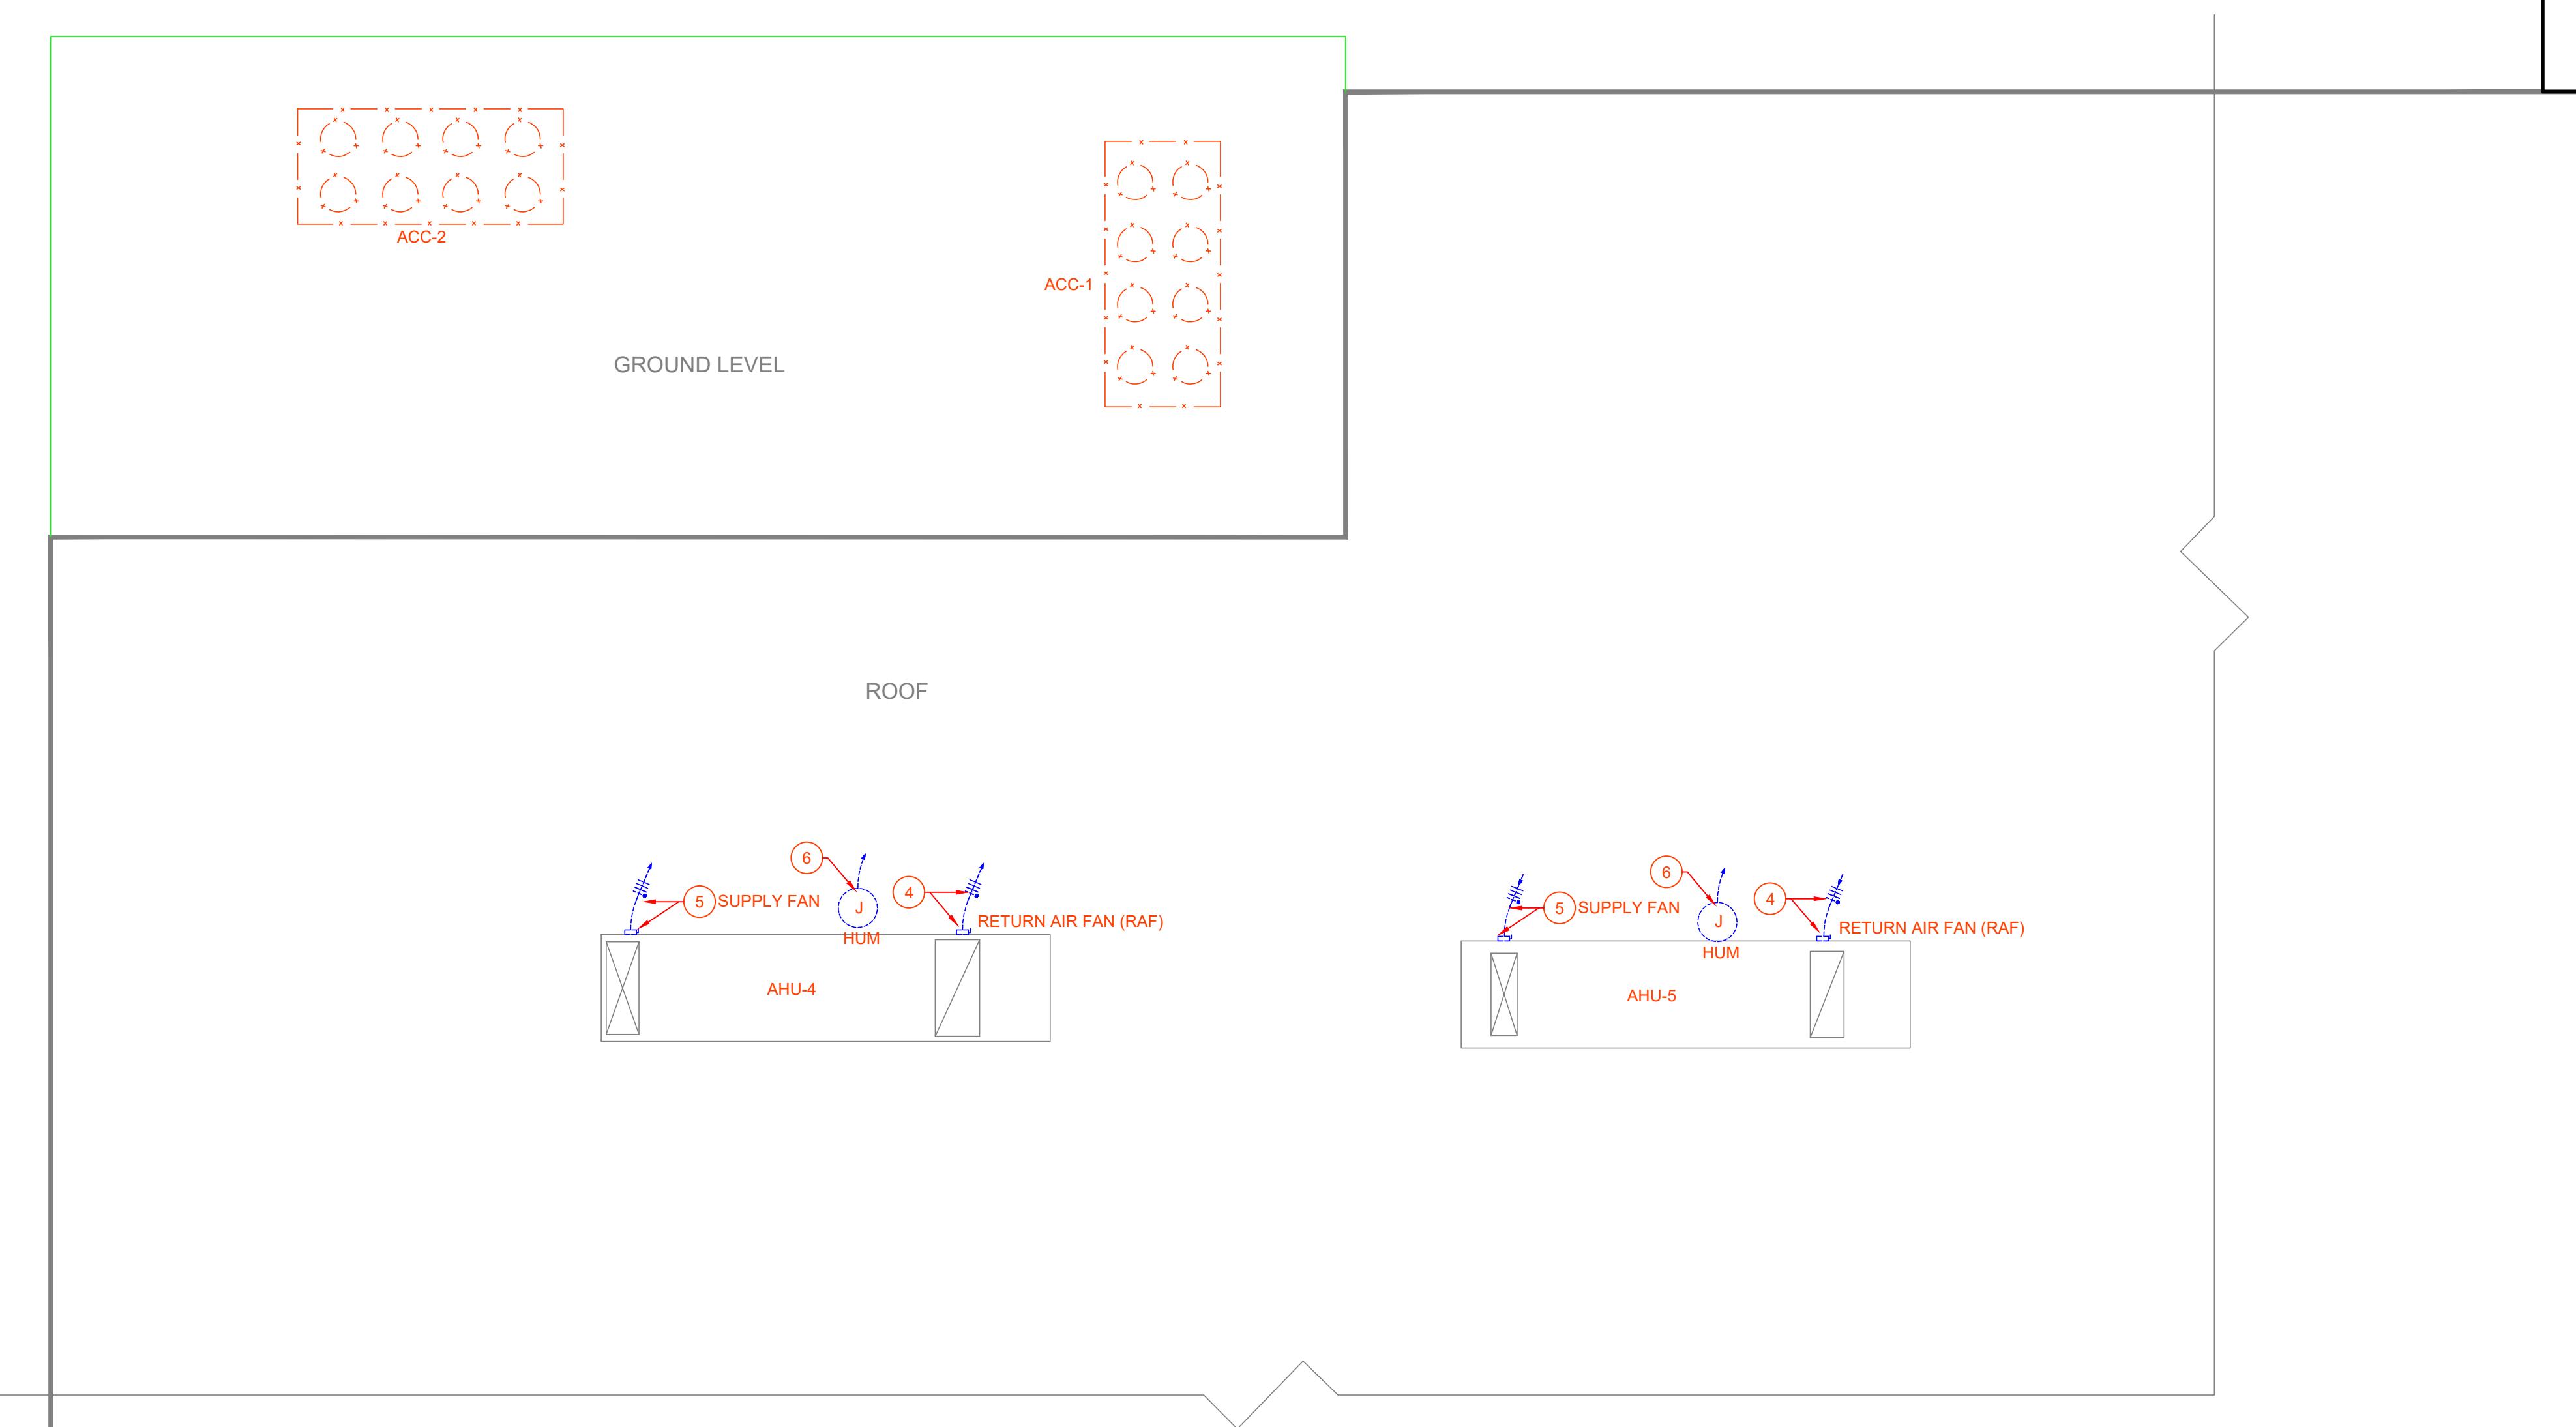

02

PARTIAL ELECTRICAL DEMOLITION ROOF PLAN


SCALE: 1/8" = 1'-0"

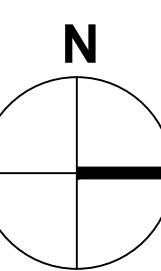

E-011




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**JPS ARLINGTON SURGERY
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01 PARTIAL ELECTRICAL PLAN

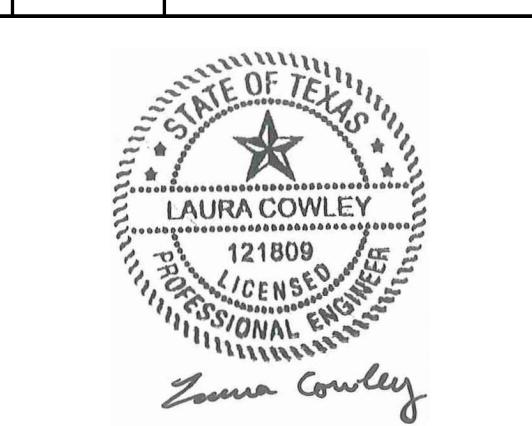

02 PARTIAL ELECTRICAL ROOF PLAN

SCALE: 1/8" = 1'-0"

ACC-2

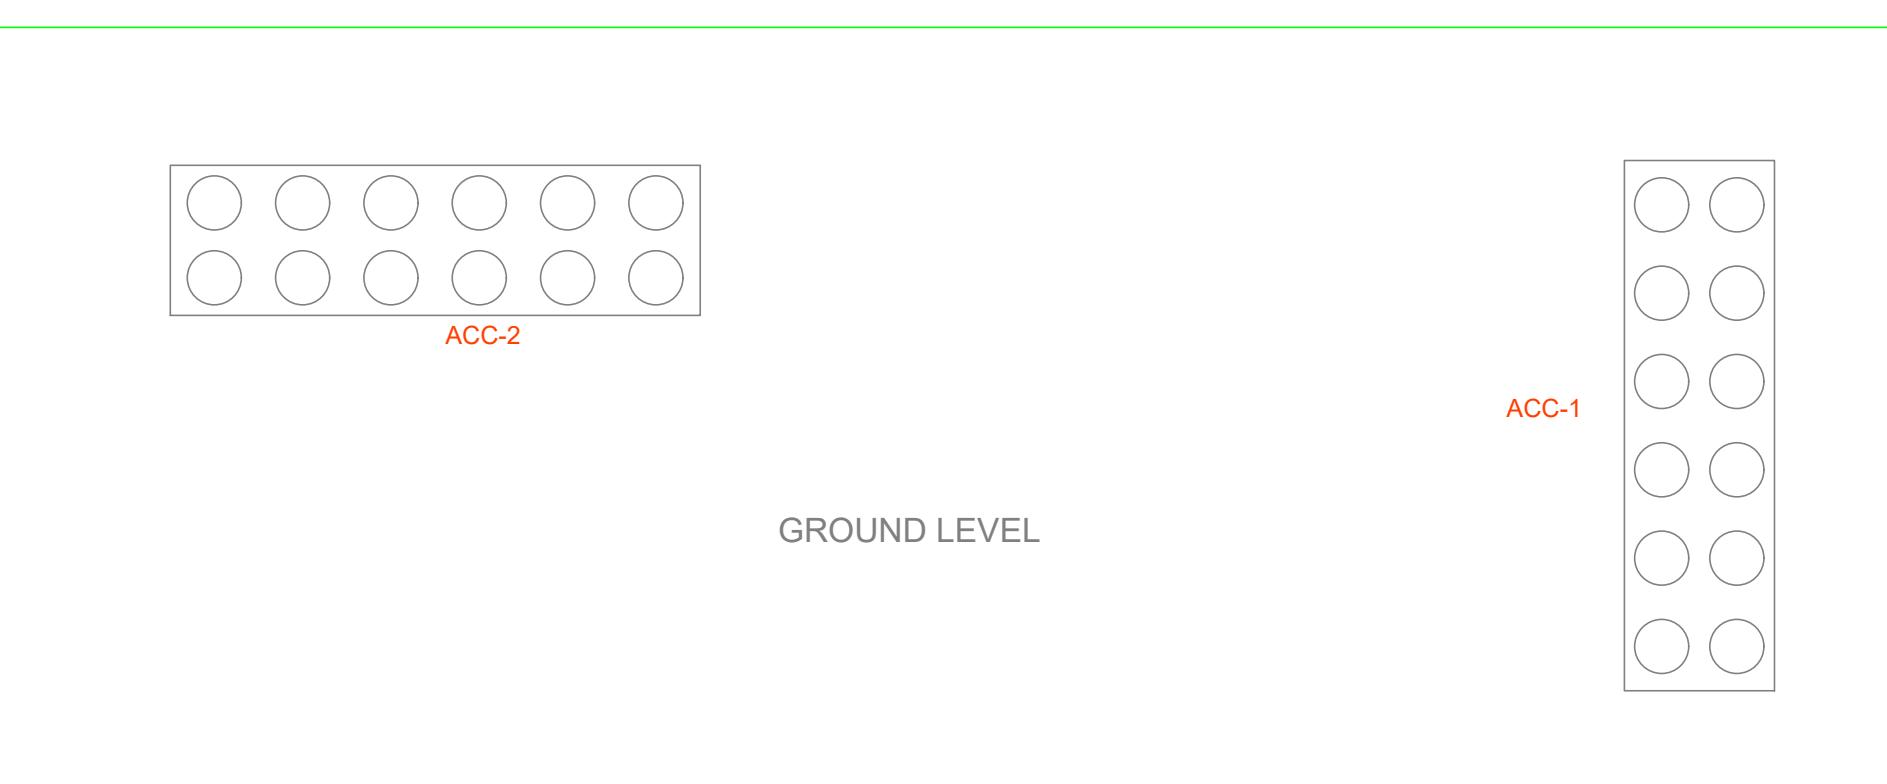

GENERAL NOTES:

1. REFER TO SHEET E-001 FOR LEGEND, ABBREVIATIONS, AND GENERAL PROJECT NOTES.
2. ALL ELECTRICAL WORK SHALL COMPLY WITH THE LATEST EDITION OF THE NATIONAL ELECTRICAL CODE (NEC) & THE AMERICAN WITH DISABILITIES ACT (ADA).
3. REFER TO RELATED MECHANICAL DRAWINGS FOR RELATED INFORMATION.
4. ELECTRICAL CONTRACTOR SHALL REFER TO MECHANICAL DRAWINGS AND SPECIFICATIONS FOR THE REQUIREMENTS ASSOCIATED WITH AIR HANDLING UNITS, VENTILATION UNITS, AND INTERLOCKING AND CONTROLS OF MECHANICAL UNITS AND THERMOSTAT LOCATIONS. VERIFY EXACT LOCATIONS FOR HVAC EQUIPMENT WITH MECHANICAL DRAWINGS.
5. WHERE WIRE SIZES ARE NOTED ON DRAWINGS, THAT SIZE SHALL BE THROUGH THE ENTIRE RUN UNLESS OTHERWISE NOTED.


ELECTRICAL KEYED NOTES:

1. COMBINATION MOTOR STARTER/SAFETY SWITCH PROVIDED BY MECHANICAL CONTRACTOR.
2. RUN 3#10, #10G - 3/4" CONDUIT TO A 35A/3P CIRCUIT BREAKER MADE AVAILABLE FROM DEMOLITION OF A 30A/3P BREAKER IN EXISTING PANEL 'EQH'.
3. REFER TO SHEET E-301 FOR CONDUIT AND WIRE SIZE.
4. PROVIDE NEMA 3R DISCONNECT 600/450/300
5. PROVIDE NEMA 3R DISCONNECT 600/450/300 MOUNT ON EXISTING UNISTRUT AND/OR BUILDING.
6. 30A/10P DISCONNECT SWITCH WITH NEMA 3R ENCLOSURE.
7. RUN 3#10, #10G - 3/4" C. TO A NEW 25A/3P CIRCUIT BREAKER IN EXISTING PANEL 'EQH'. MATCH BREAKER AIC RATING WITH EXISTING.
8. RUN 3#10, #10G - 3/4" C. TO A NEW 40A/3P CIRCUIT BREAKER IN EXISTING PANEL 'EQH'. MATCH BREAKER AIC RATING WITH EXISTING.
9. CONNECT TO MECHANICAL EQUIPMENT.
10. RUN 3#12, #10G - 3/4" C. TO 25A/3P BREAKER IN 'MH' MADE AVAILABLE BY DEMOLITION.
11. RUN 3#12, #12G - 3/4" C. TO 20A/3P BREAKER IN 'MH' MADE AVAILABLE BY DEMOLITION.
12. CIRCUIT TO 20A/1P BREAKER IN PANEL 'PL'.

PROJECT #: 05194.09

SHEET TITLE:
PARTIAL
ELECTRICAL
PLAN
SHEET #:

E-111

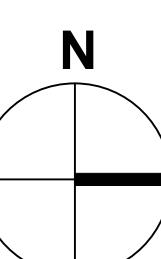


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PROJECT #: 05194.09

SHEET TITLE:
PARTIAL
ELECTRICAL
DEMOLITION 1LINE
SHEET #:

E-301

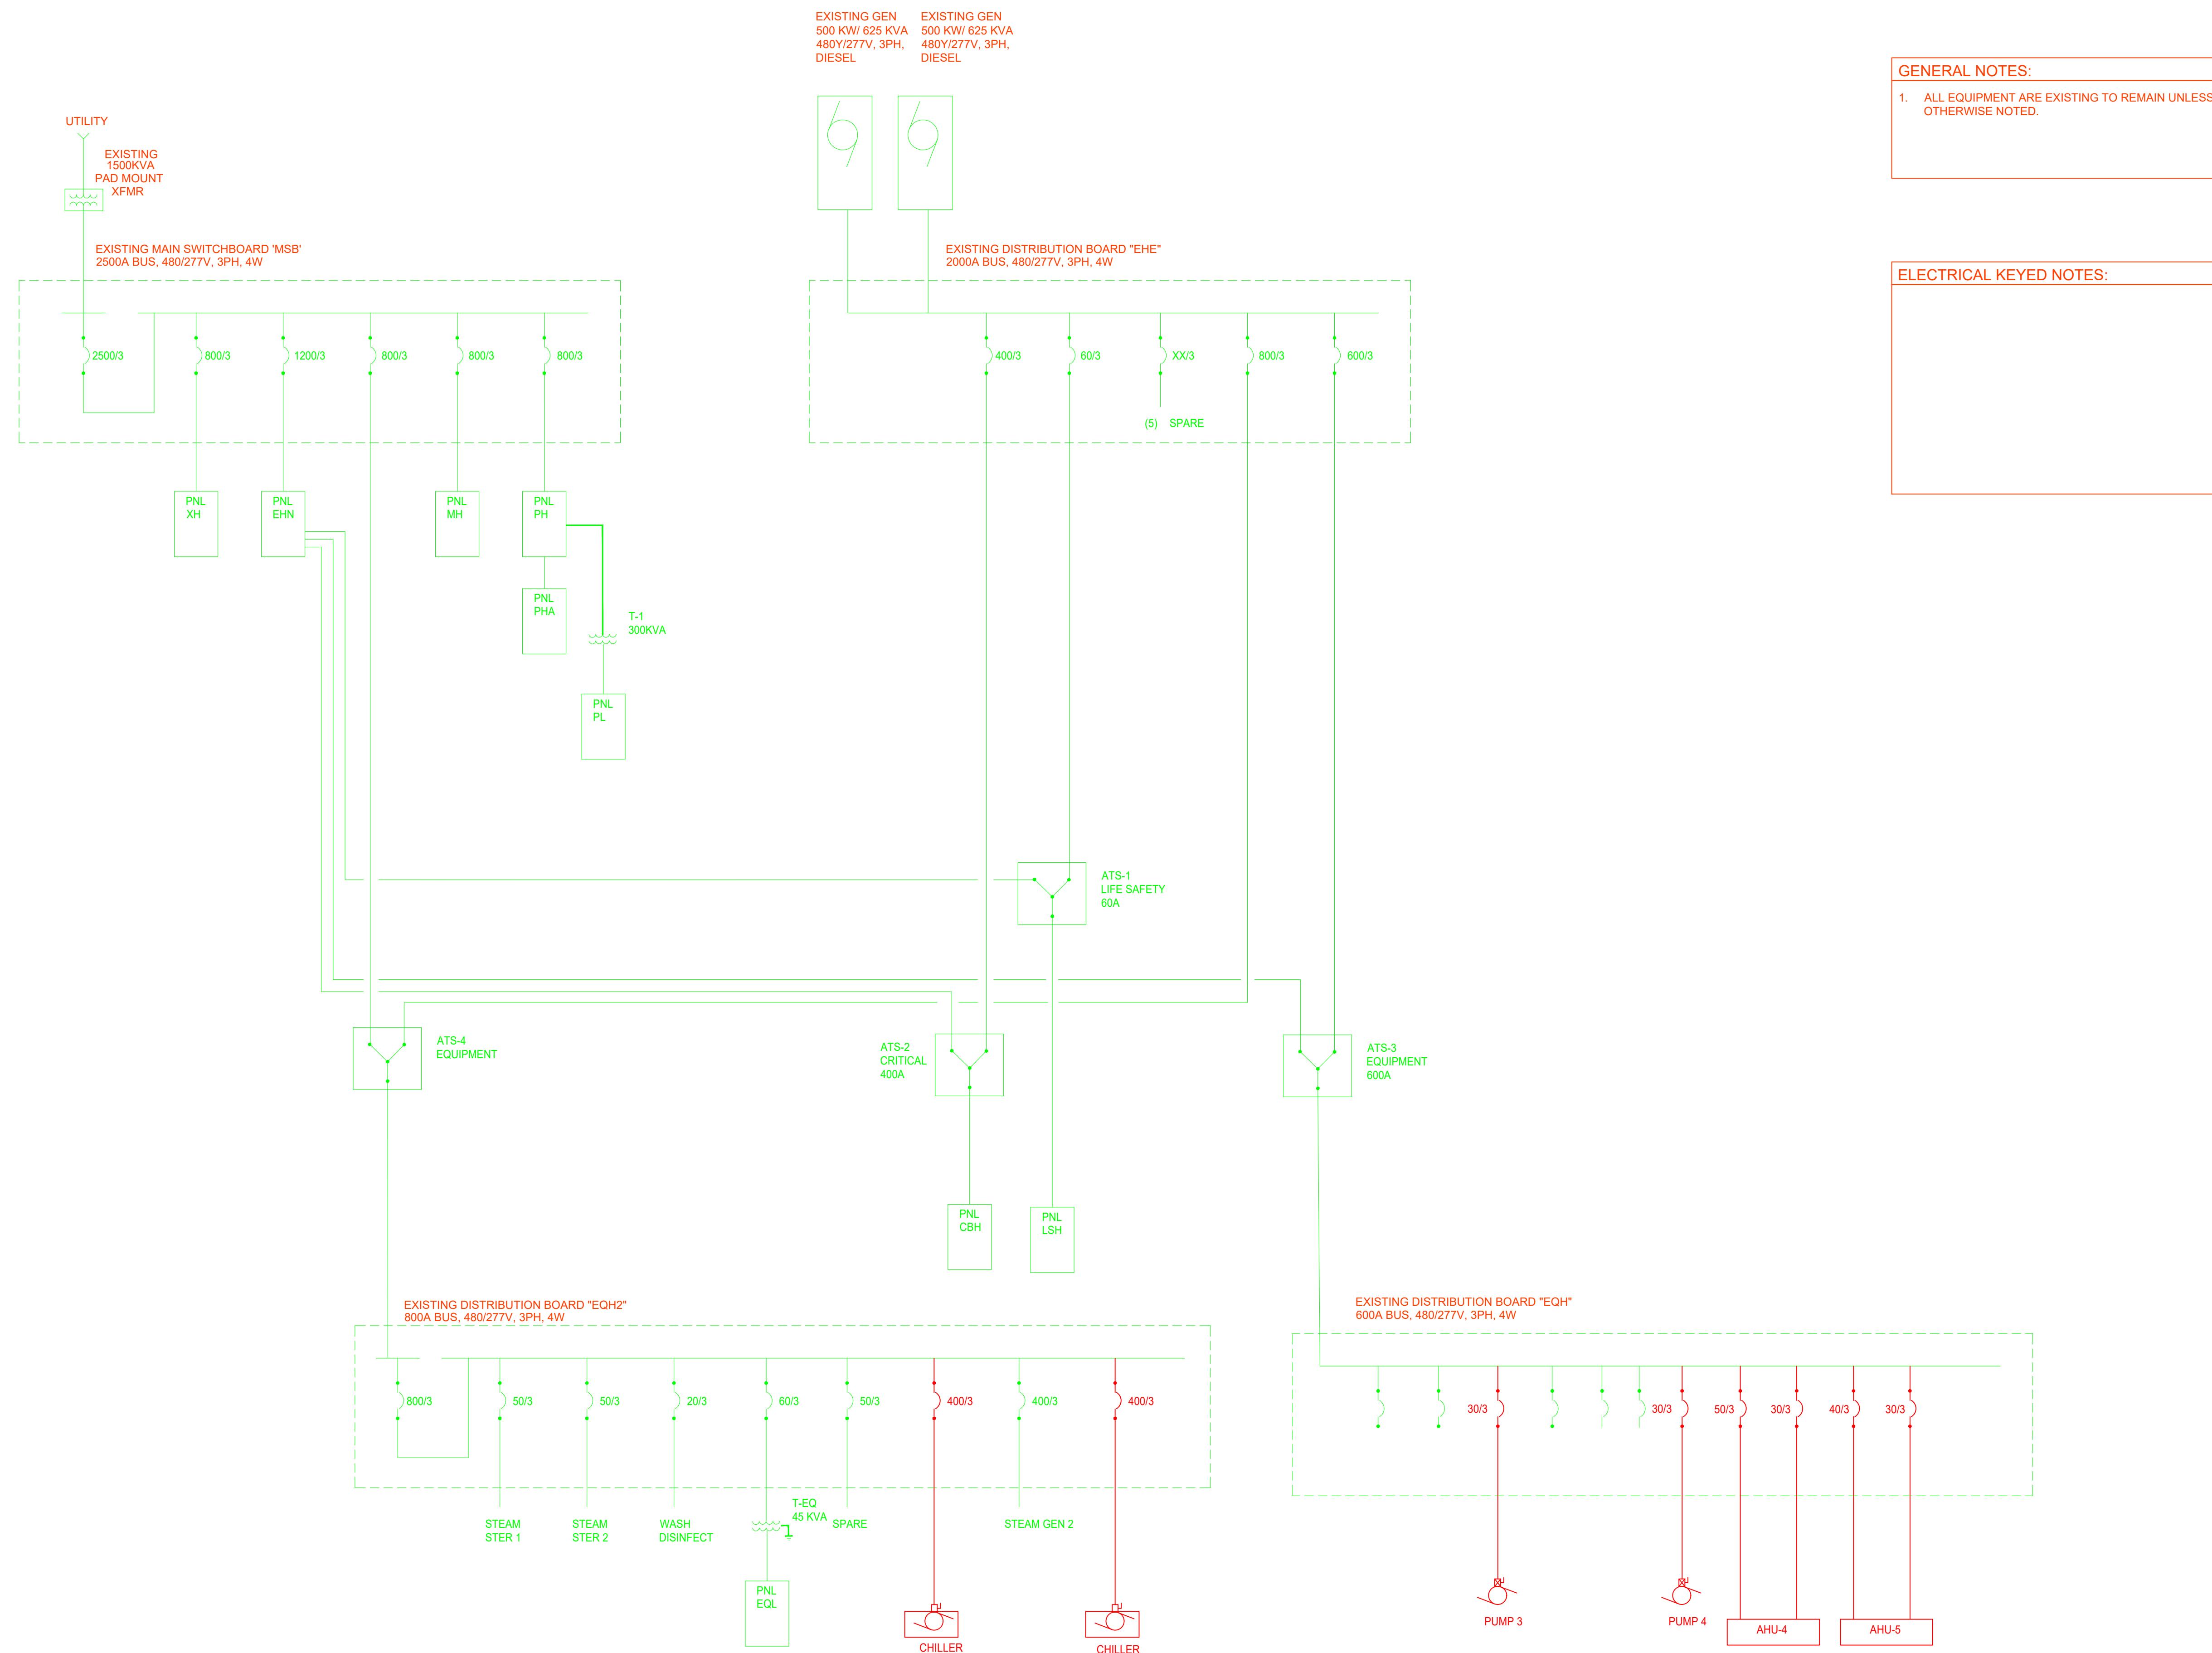

01 PARTIAL ELECTRICAL DEMOLITION 1-LINE
SCALE: NONE


E-301

**JPS ARLINGTON SURGERY
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ARLINGTON, TX 76018**

PROJECT #: 05194.09

SHEET TITLE:
PARTIAL
ELECTRICAL NEW
1LINE
SHEET #:

E-302

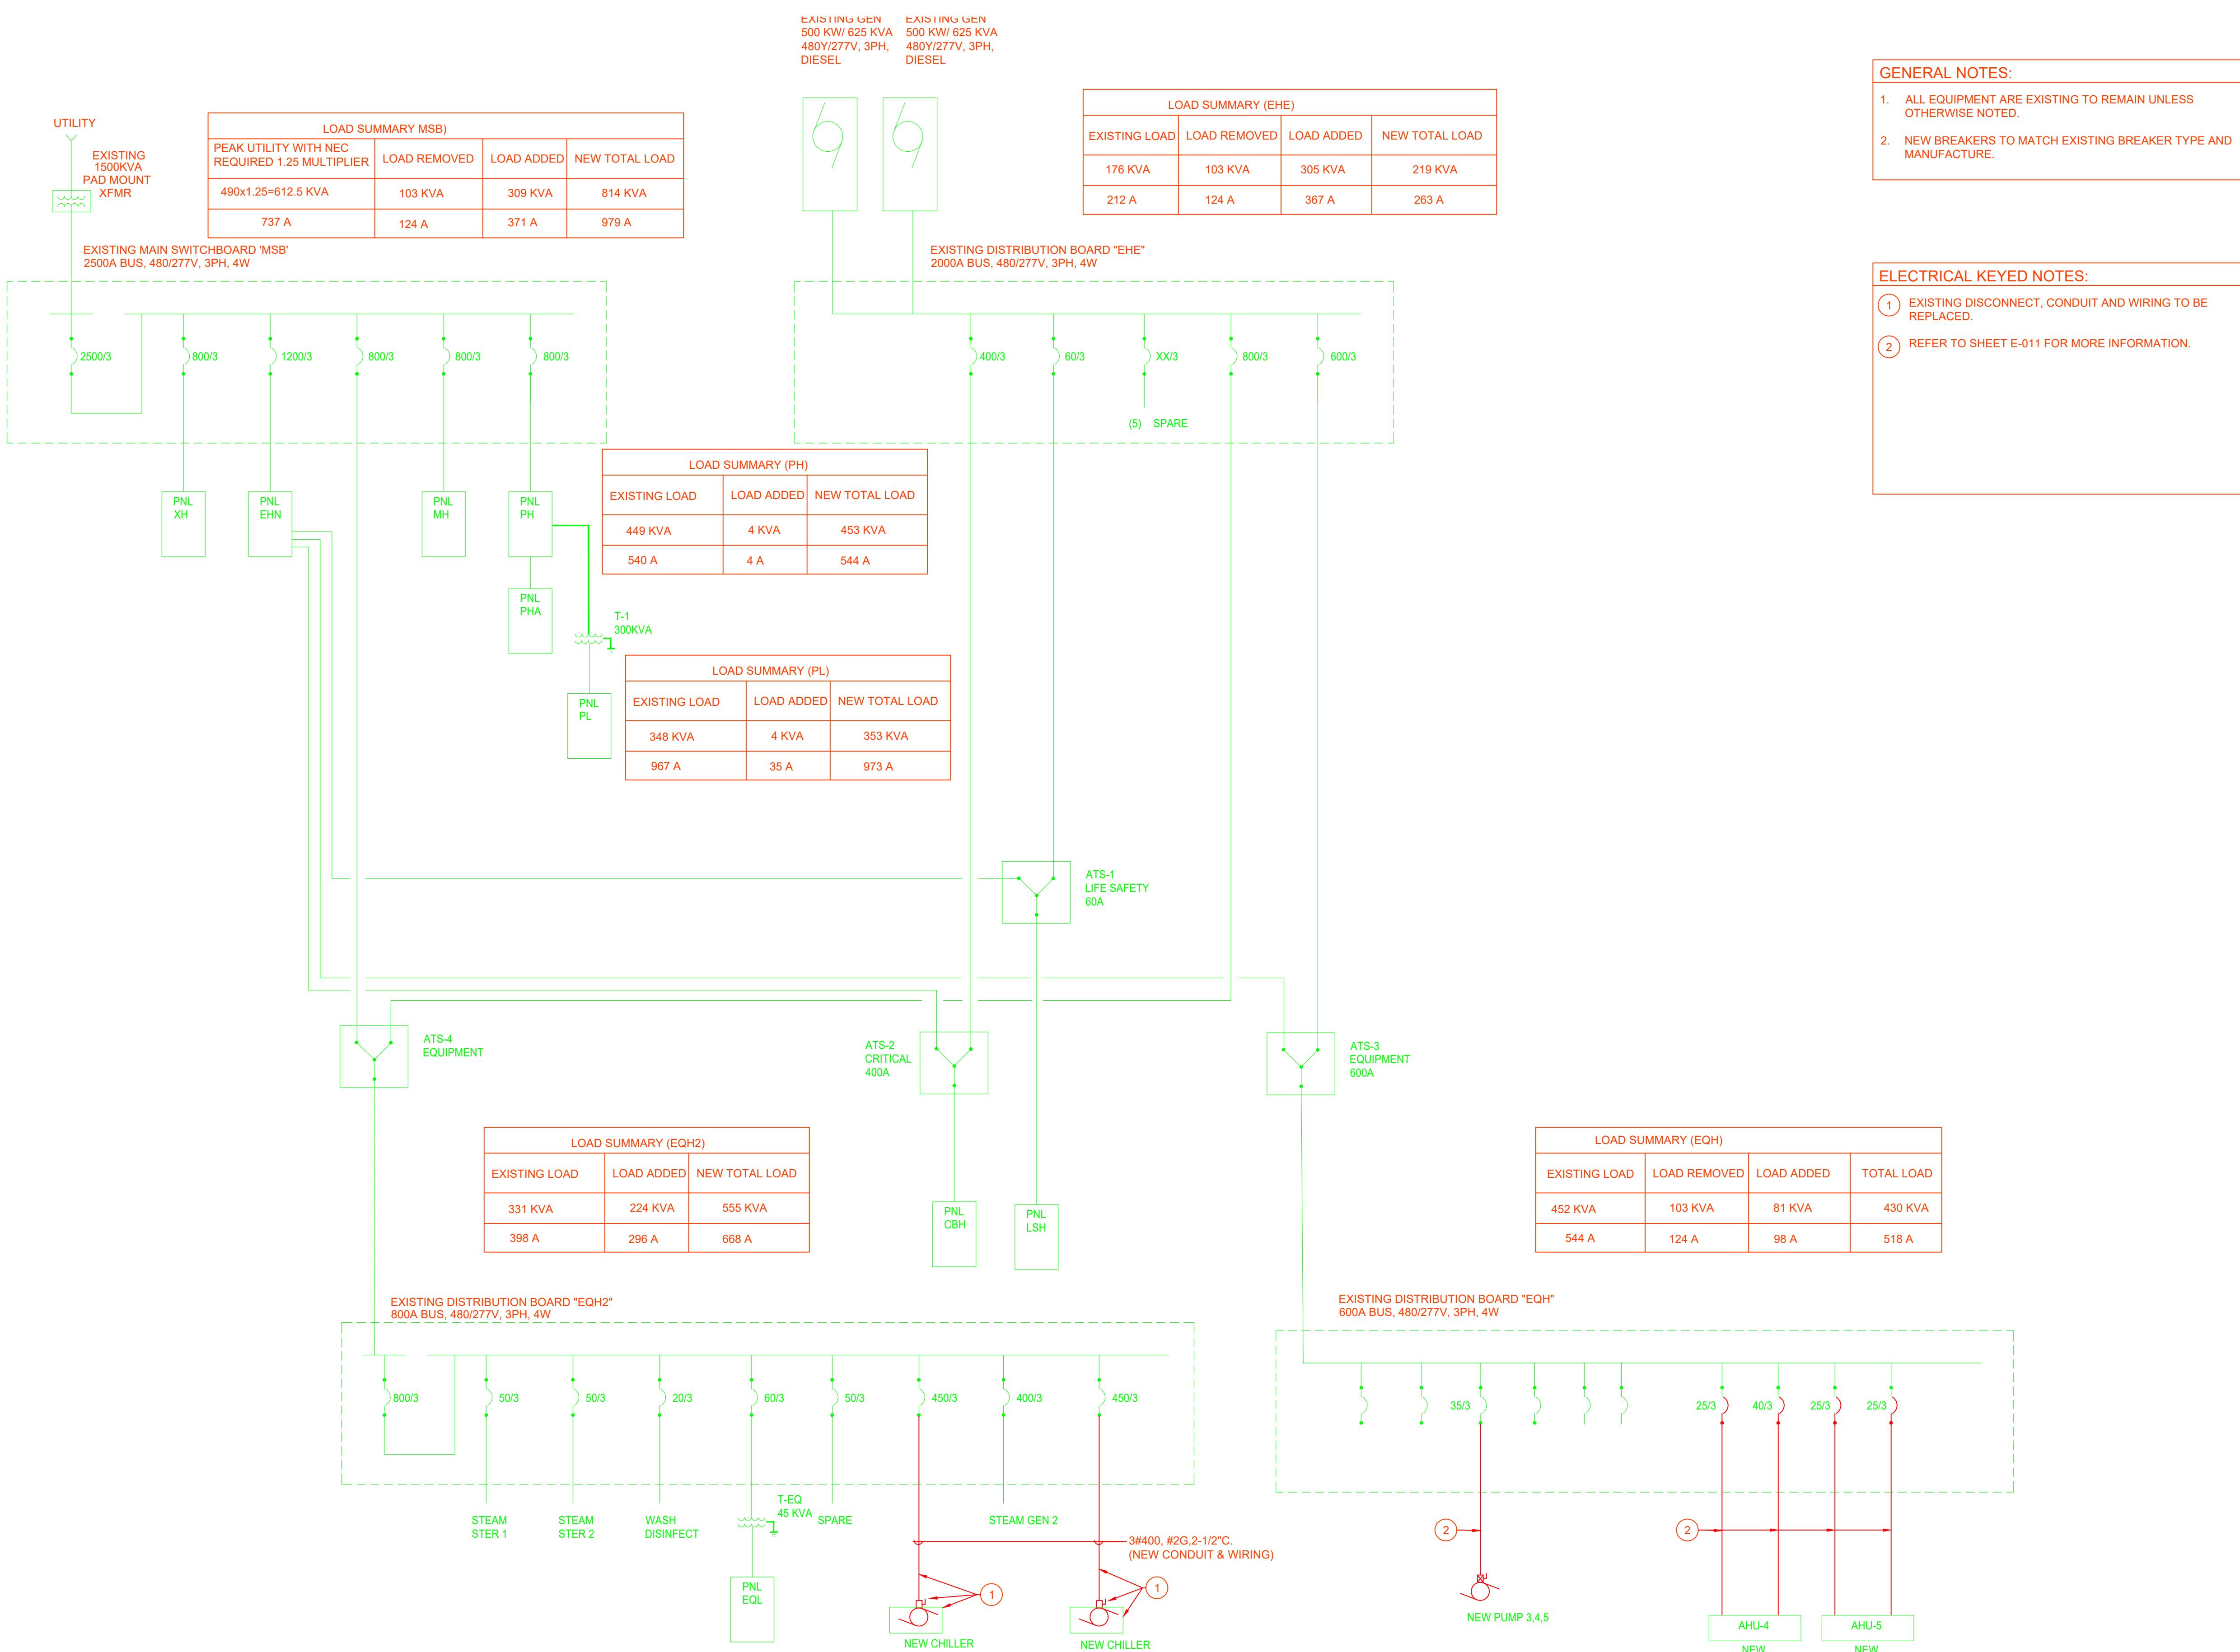

01 PARTIAL ELECTRICAL NEW 1-LINE

SCALE: NONE

E-302